

ADDENDUM

Public Building Commission of Chicago | Richard J. Daley Center | 50 West Washington Street, Room 200 | Chicago, Illinois 60602 | (312) 744-3090 | pbcchicago.com

ADDENDUM NO.: 04

PROJECT NAME: Legler Regional Library Renovations

PROJECT NO.: 08310

CONTRACT NO.: C1597

DATE OF ISSUE: December 11, 2019

NOTICE OF CHANGES, MODIFICATIONS, OR CLARIFICATIONS TO CONTRACT DOCUMENTS

The following changes, modifications, or clarifications are hereby incorporated and made an integral part of the Contract Documents. Unless clearly expressed otherwise by this Addendum, all terms and conditions defined in the original Contract Documents shall continue in full force and effect and shall have the same meaning in this Addendum. Issued Addenda represent responses/clarifications to various inquiries. Contractors shall be responsible for including all associated labor/material costs in its bid. Drawings/specifications corresponding to inquiry responses will be issued with the Issue for Construction Documents, upon issuance of building permit.

ITEM NO. 1: CHANGE TO KEY DATES

Change 1 Bid Due Date and Time has been RESCHEDULED to Friday, December 13, 2019 at 11:00a.m.

Change 2 Pre-Award Meeting Date and Time has been RESCHEDULED to Monday, December 16, 2019 at

11:00a.m.

ITEM NO. 2: REVISIONS TO BOOK 1 – PBC INSTRUCTIONS TO BIDDERS

None.

ITEM NO. 3: REVISIONS TO BOOK 2 – PBC STANDARD TERMS AND CONDITIONS

None.

ITEM NO. 4: REVISIONS TO BOOK 3 – TECHNICAL SPECIFICATIONS

None.

ITEM NO. 5: REVISIONS TO DRAWINGS

Change 1 REVISED Drawing No A-601, DOOR SCHEDULE AND DETAILS: Revised 107-B, 107-C, 107-

D, 119-B, 119-C, 119-D, 206-A, 227-A, Frame Repair Needed: Ext: See Notes B, C, D Below;

Int: Sand & Stain.

Change 2 REVISED Drawing No A-621, WINDOW SCHEDULE AND DETAILS: Revised W24, W25, &

W26, Frame Repair Needed: Clean, Sand, and Paint Frame.

Change 3 REVISED Drawing No A-621, WINDOW SCHEDULE AND DETAILS: Revised W24, W25, &

W26, Comments: Replace Broken Wire Glass Panes to Match Existing.

Change 4 REVISED Drawing No A-621, WINDOW SCHEDULE AND DETAILS: Revised W62,

Comments: Replace IGU in Bottom Sash to Match Existing.

Change 5 REVISED Drawing No A-621, WINDOW SCHEDULE AND DETAILS: Revised W14, W15, W16,

W17, W18, W19, W20, W21, W22, W23, W39, W40, W41, W42, W43, W44, W45, W46, W47, W48, W49, W50, W51, W52, W53, W54, W55, W56, W57, W58, W69, W70, W71, & W72,

Frame Repair Needed: Ext: See Notes B, C, D Below; Int: Sand & Stain.

ITEM NO. 6: REQUESTS FOR INFORMATION

RFI-1.

Question: In reviewing the Existing Window Repair Schedule there are four windows (W24, W25, W26, and

W62) that are marked "Reproduce/Replace". There is no specification for new/replacement

windows so please provide a specification or directive on how to handle these windows.

Date of Issue: December 11, 2019 Page 1 of 2

Response: Specification Section 08 01 52.61 Wood Window and Door Repairs was revised and included in Addendum No. 3 issued on December 6, 2019. Sheet No. A-621, Window Schedule and Details, has been revised and is included in this Addendum.

This Addendum includes the following attached Specifications and/or Documents:


1. None.


This Addendum includes the following attached Drawings:

- 1. A-601 DOOR SCHEDULE AND DETAILS, dated 12/11/2019
- 2. A-621 WINDOW SCHEDULE AND DETAILS, dated 12/11/2019

END OF ADDENDUM NO. 04

Date of Issue: December 11, 2019 Legler Regional Library Renovations_C1597 - Addendum No. 4

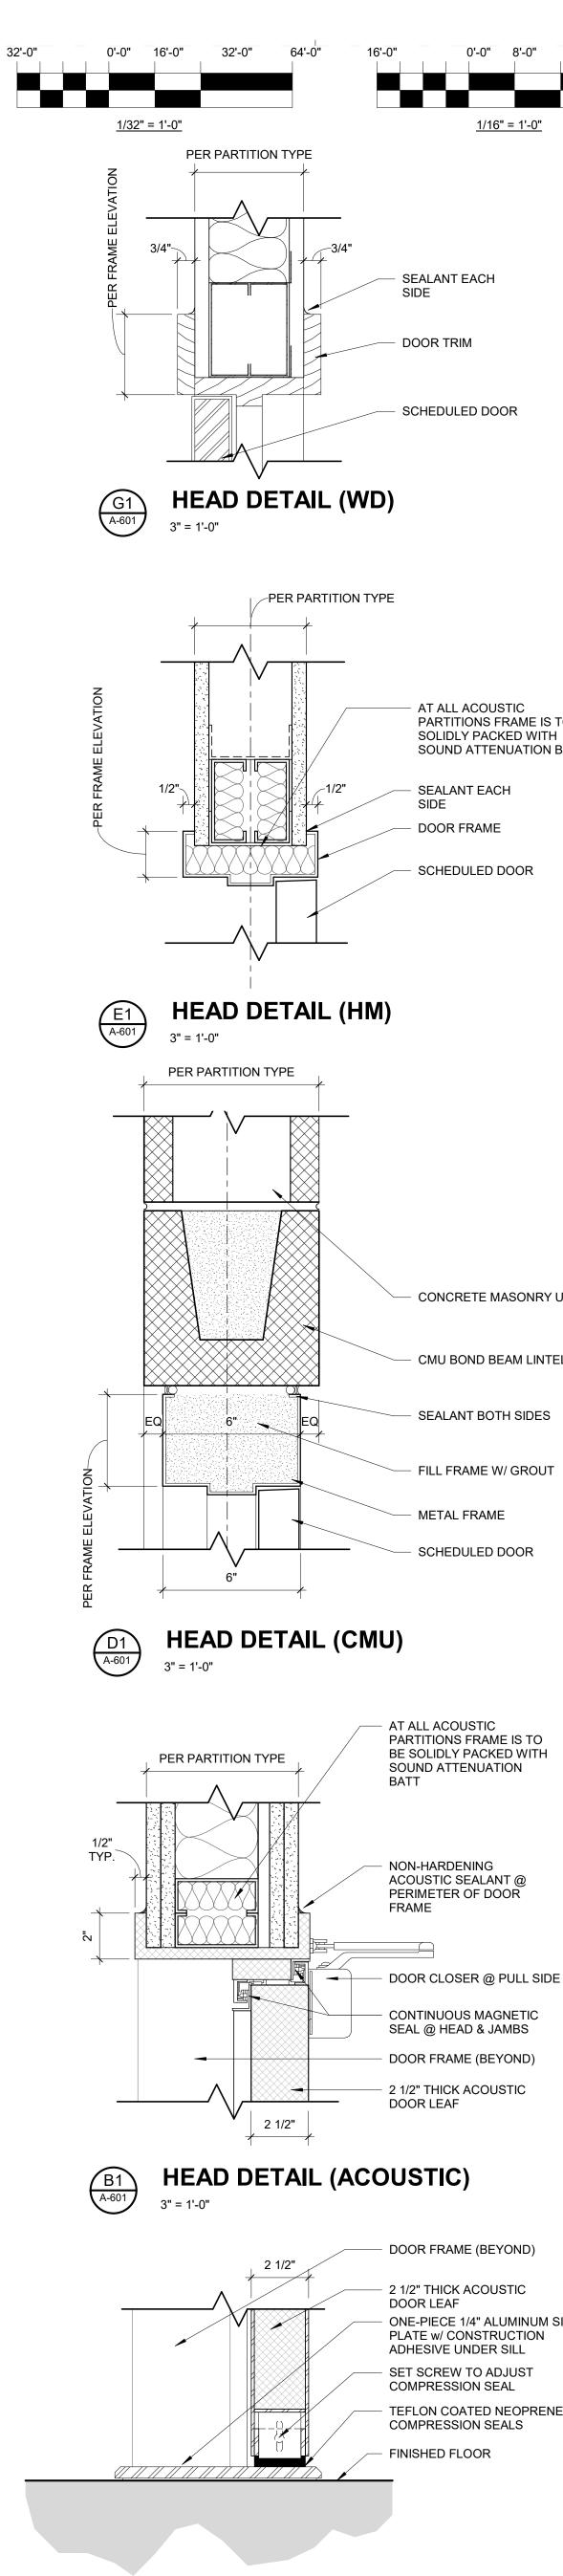

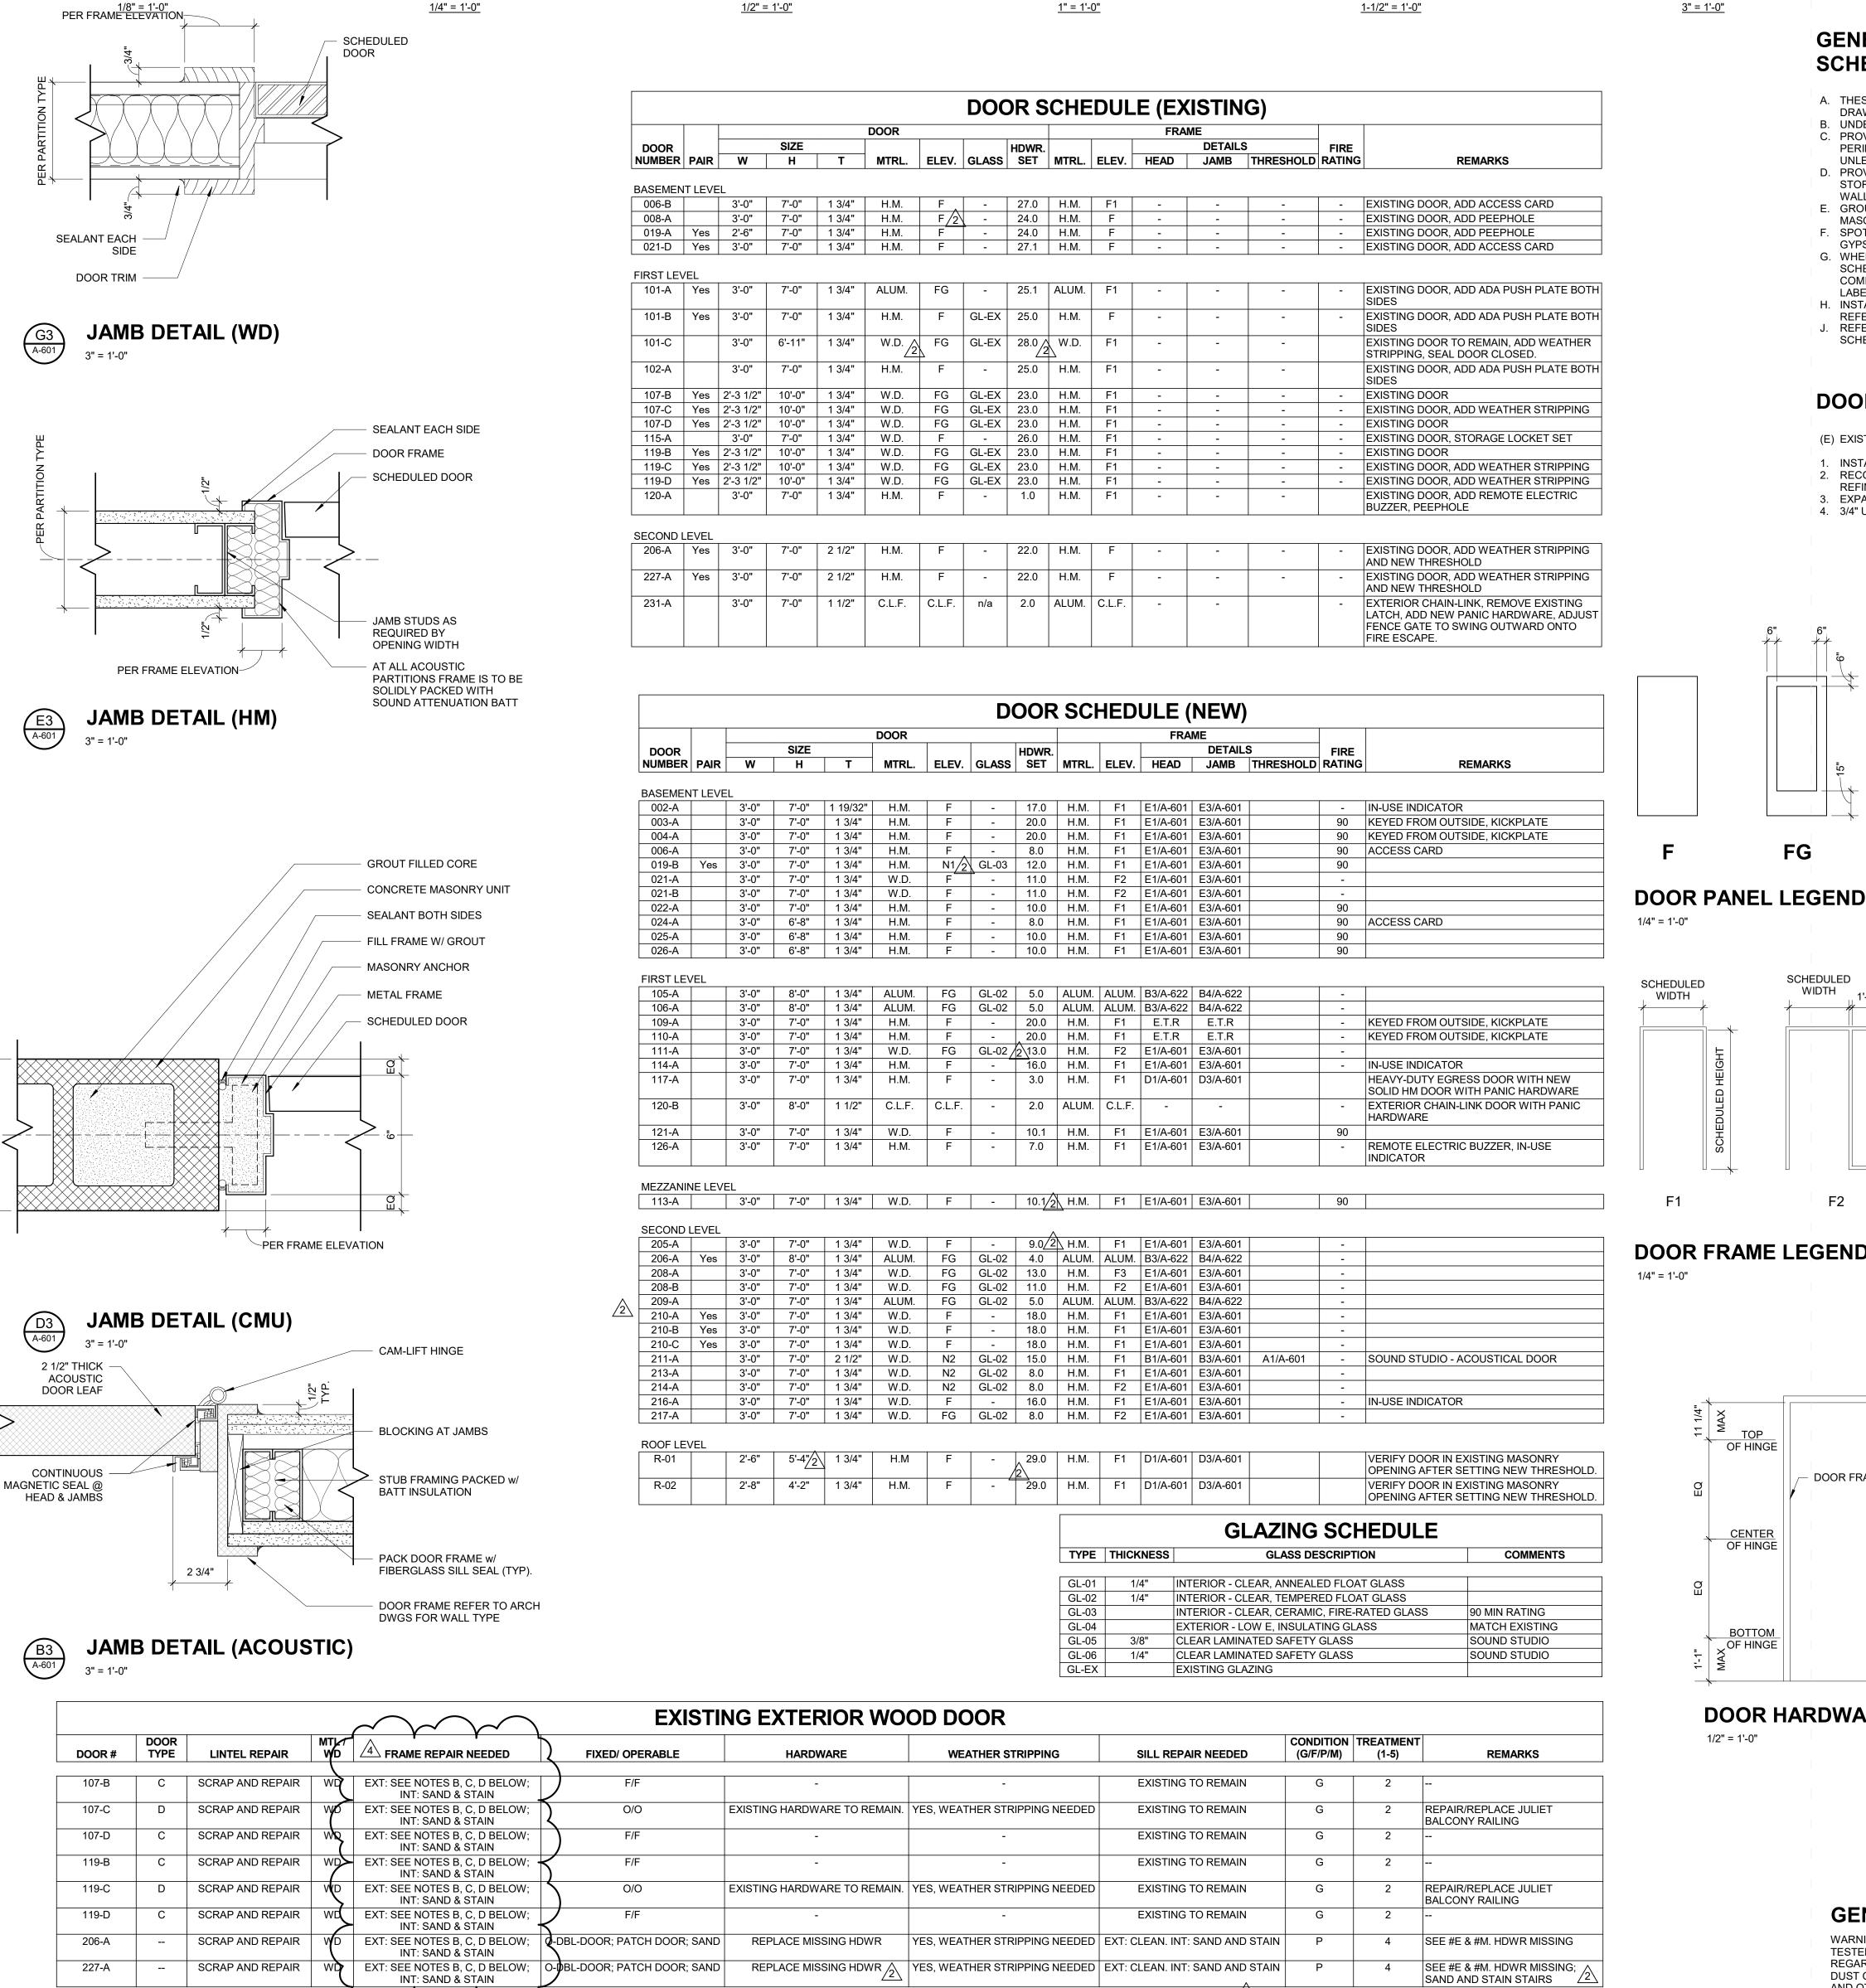

0'-0" 2'-0" 4'-0"

0'-0" 4'-0" 8'-0"

<u>1/16" = 1'-0"</u>

SEALANT EACH

DOOR TRIM

SCHEDULED DOOR

AT ALL ACOUSTIC

SEALANT EACH

DOOR FRAME

SCHEDULED DOOR

CONCRETE MASONRY UNIT

- CMU BOND BEAM LINTEL

SEALANT BOTH SIDES

- FILL FRAME W/ GROUT

METAL FRAME

AT ALL ACOUSTIC

NON-HARDENING

ACOUSTIC SEALANT @

PERIMETER OF DOOR

CONTINUOUS MAGNETIC

SEAL @ HEAD & JAMBS

DOOR FRAME (BEYOND)

2 1/2" THICK ACOUSTIC

DOOR FRAME (BEYOND)

ONE-PIECE 1/4" ALUMINUM SILL

PLATE w/ CONSTRUCTION

TEFLON COATED NEOPRENE

ADHESIVE UNDER SILL

SET SCREW TO ADJUST

COMPRESSION SEAL

COMPRESSION SEALS

FINISHED FLOOR

DOOR LEAF

PARTITIONS FRAME IS TO

BE SOLIDLY PACKED WITH

SOUND ATTENUATION

SCHEDULED DOOR

PARTITIONS FRAME IS TO BE SOLIDLY PACKED WITH

SOUND ATTENUATION BATT

DOOR FRAME LEGEND ALL DIMENSIONS ARE TO THE CENTERLINE OF THE TOP HARDWARE INDICATED, UNO OF HINGE COAT HOOK DOOR FRAME **DEADLOCK CYLINDER** OF HINGE LEVER / EXIT DEVICE OF HINGE FLOOR SLAB DOOR HARDWARE LOCATION DIAGRAM 1/2" = 1'-0"

SCHEDULED

WIDTH

<u>3" = 1'-0"</u>

GENERAL DOOR

DRAWINGS.

SCHEDULE.

4. 3/4" UNDERCUT.

(E) EXISTING DOOR TO REMAIN

SCHEDULE NOTES

UNLESS OTHERWISE INDICATED.

MASONRY WALL CONSTRUCTION.

GYPSUM BOARD WALL CONSTRUCTION.

A. THESE GENERAL NOTES APPLY TO A-601 DOOR SCHEDULE

B. UNDERCUT DOORS AS REQUIRED BY FINAL FLOOR FINISH C. PROVIDE SEALANT BETWEEN HOLLOW METAL FRAME

D. PROVIDE SEALANT BETWEEN INTERIOR AND EXTERIOR STOREFRONT FRAME PERIMETERS AND SURROUNDING

E. GROUT FULL NEW HOLLOW METAL DOOR FRAMES IN

F. SPOT GROUT NEW HOLLOW METAL DOOR FRAMES IN

H. INSTALL DOOR GLASS USING WET-GLAZING METHOD.

DOOR SCHEDULE REMARKS

1. INSTALL NEW DOOR AND FRAME IN EXISTING OPENING.

REFINISH DOOR, REINSTALL EXISTING HARDWARE.

3. EXPAND EXISTING OPENING AND ADD NEW LINTEL.

2. RECONDITION AND PATCH DOOR & FRAME. REFURBISH AND

SCHEDULED

WIDTH

F3

REFER TO PROJECT MANUAL DIVISION 8 FOR GLAZING.

J. REFER TO PROJECT MANUAL DIVISION 8 FOR HARDWARE

G. WHERE A FIRE RATING IS INDICATED ON THE DOOR SCHEDULE, HARDWARE AND DOOR ASSEMBLY

PERIMETERS AND SURROUNDING WALL CONSTRUCTION

WALL CONSTRUCTION UNLESS OTHERWISE INDICATED.

COMPONENTS SHALL MEET THE REQUIREMENTS OF THAT

GENERAL ENVIRONMENTAL NOTES

WARNING: VARIOUS COMPONENTS/SURFACES WITHIN THE BUILDING HAVE TESTED ABOVE AND BELOW THE LEAD THRESHOLD OF 1.0 MG/CM2 REGARDLESS OF CONCENTRATIONS, THERE IS A POTENTIAL FOR LEAD DUST GENERATION DURING DRILLING, CORING, PAINTING PREPARATION AND OTHER RENOVATION ACTIVITIES FOR ALL SMALL SCALE DISTURBANCES, THE CONTRACTOR SHALL FACILITATE THE APPROPRIATE MEASURES FOUND IN PROJECT SPECIFICATIONS TO PREVENT DUST MITIGATION TO OTHER PARTS OF THE BUILIDNG. LEAD-BASED PAINT MAY BE PRESENT WITHIN THE BUILDING. IT IS THE RESPONSIBILITY OF THE CONTRACTOR TO TAKE APPROPRIATE SAFETY MESURES IN ACCORDANCE WITH APPLICABLE FEDERAL, STATE, AND LOCAL RULES AND REGULATIONS INCLUDING OSHA (1926.62) COMPLIANCE. WASTE CHARACTERIZATION AND WASTE DISPOSAL. ALL WORK WITH SURFACES CONTAINING LEAD-BASED PAINT SHALL BE DONE IN ACCORDANCE WITH SPECIFICATIONS PROJECT SPECIFICATIONS.

WARNING: ASBESTOS-CONTAINING BUILDING MATERIALS ARE OR MAY BE PRESENT IN THIS BUILDING. NO PERSON MAY DISTURB ASBESTOS-CONTAINING MATERIALS UNLESS THAT PERSON IS A LICENSED ASBESTOS WORKER OR CONDUCTS SUCH WORK IN ACCORDANCE WITH SPECIFICATIONS CONTAINED IN THE PROJECT DOCUMENTS AND IN COMPLIANCE WITH ILLINOIS DEPARTMENT OF HEALTH RULES AND

CHICAGO SEAL | DATE

DOB STAMP APPROVAL

atio gion egle

Architect of Record:

PURSUANT TO THE AGREEMENT WITH RATIO. NO OTHER USE WRITTEN CONSENT OF RATIO. ALL COMMON LAW RIGHTS OF COPYRIGHT AND OTHERWISE ARE HEREBY SPECIFICALLY RESERVED.

ADDRESS: 30 West Monroe Street Suite 500 Chicago, Illinois 60603 PHONE: 312-465-2359

WEB: www.ratiodesign.com **TERRA Engineering Ltd.** 225 W. Ohio Street, 4th Floor, Chicago, IL 60654 (312) 467-0123 Civil Engineers of Record

Stearn-Joglekar, Ltd. 223 W Jackson Blvd # 1110, Chicago, IL 60606 Structural Engineers of Record Brush Architects, LLC 4200 N Francisco Ave, Chicago, IL 60618

Facade Consultant RCL Engineering Group PO BOX 4458, Skokie, IL 60076 (847) 965-3366

(312) 925-3070

Roofing Consultant db | HMS 303 W Erie St #510, Chicago, IL 60654

MEPFP Engineers of Record Gwen Grossman Lighting Design 53 W Jackson Blvd, Chicago, IL 60604 (312) 877-5125 Lighting Design Consultant

216 S. Jefferson St, Suite LL2, Chicago, IL 60661 (312) 332-5444 Elevator Consultant

Carnow, Conibear & Assoc., Ltd. 600 West Van Buren, Suite 500, Chicago, IL 60607 (312) 782-4486 nvironmental Consultant

> **ISSUE FOR BID** 11/27/19 **ADDENDUM #2** ADDENDUM #3 **ADDENDUM #4** 12/11/19

PBC Project Name: Legler Regional Library PBC Contract No: C1597 PBC Project No.: 08310

DOOR SCHEDULE AND DETAILS

SILL DETAIL (ACOUSTIC)

A. THESE EXISTING WOOD WINDOW AND WOOD DOOR REPAIRS APPLY TO EXISTING WOOD WINDOW SCHEDULE (A-601) AND EXISTING WOOD DOOR SCHEDULE (A-621). B. REFER TO SPECSIFICATIONS 080152.61 - WOOD WINDOW REPAIRS FOR

REFURBISHING AND REPAIRING WOOD WINDOWS AND TRIM. C. EXISTING WOOD CASEMENT WINDOW SASHS THAT ARE REMOVED FOR RESTORATION WORK UNDER SHOP CONDITION, CONTRACTOR TO PROVIDE PROTECTION TO THE EXISTING BUILDING FROM THE ELEMENTS AND

VANDALISM UNTIL THE SASHES & DOORS ARE REINSTALLED. D. STRIP BOTH SURFACES OF THE WINDOWS, DOORS AND FRAMES DOWN TO BARE WOOD, RESTORE THESE ITEMS AND PREPARE FOR NEW FINISH. ALL EXTERIOR FINISH OF THE WINDOWS, DOORS & FRAMES SHALL BE PAINTED. INTERIOR FINISH OF THESE ITEMS SHALL MATCH THE EXISTING TRIM.

EXISTING WINDOW AND DOOR REPAIR GENERAL NOTES

E. REPLACE THE ENTIRE WOOD WINDOW OR DOOR IF DECAYED WOODEN ELEMENT DAMAGE COVERS MORE THAN 50% OF THE PIECE. USE EPOXY FILLER WHEN IF 75% PERCENT OF THE ELEMENT IS STILL SOUND MATERIAL.

REFINISH EXPOSED WOOD SURFACES TO MATCH EXISTING (SEE SPECS). G. EXISTING WOOD WINDOWS (CASEMENT AND DOUBLE HUNG) AND DOORS EXTERIOR MOLDING, FRAMING AND SILLS SHALL BE REPAIRED WITH WATER RESISTANT RESIN CONSOLIDANT AND STRUCTURAL NO-SHRINK EPOXY ADHESIVE PUTTY, IF TOTALLY DETERIORATED, NOTIFY AOR, PRIOR TO REPLACEMENT (MATCH EXISTING PROFILE).

. WOOD BLOCKING AND SHIM SHALL BE TREATED WOOD. PERMANENTLY SECURE ALL FIXED SASHES AS INDICATED IN EXISTING WINDOW SCHEDULE PROVIDE SEALANT AROUND THE PERIMETER OF THE OPENING. REMOVE EXISTING AND PROVIDE NEW WEATHERSTRIPPING ON ALL OPERABLE

K. CHECK EXISTING HARDWARE FOR PROPER OPERATION. CLEAN AND LUBRICATE ALL EXISTING HARDWARE. REPLACE ALL DAMAGED BROKEN OR MISSING HARDWARE WITH HARDWARE FROM OPERABLE SASHES WITH SIMILAR HARDWARE WHICH ARE SCHEDULED TO BECOME FIXED.

MASONRY JOINT ADJACENT TO WINDOW FRAME SHALL BE IN-LINE WITH

EXISTING WOOD TRIM ON ALL SIDES. M. SALVAGE EXISTING HARDWARE FOR RE-USE IF EXISTING WD DOOR REPLACEMENT IS REQUIRED. N. REFER TO DETAIL E3/A-622 FOR REPLACEMENT OF SEALANT & GLAZING

PUTTY ALONG ENTIRE PERIMETER (TOP, BOTTOM, AND BOTH SIDES) OF EACH INSULATED GLASS UNIT (IGU) WITH A HARDWOOD STOP.

TREATMENT CLASSIFICATIONS CLEAN, SCRAPE & PAINT 2. CLEAN, SCRAPE, PATCH, SAND & REPAINT (REPAIR CLASS I) 3. MINOR REPAIRS (RE-GLAZE & RE-PUTTY) (REPAIR CLASS II)

G - GOOD CONDITION

F - FAIR CONDITION

M - MISSING

P - POOR CONDITION

4. MAJOR REPAIRS - REPLACE WOOD (REPAIR CLASS III) 5. REPRODUCE/ REPLACE

